

- CONSTRUCT CURBING, PAVEMENT AND SIDEWALKS.
- COMPLETE STRUCTURE.
- e. PHASE V (DEPENDENT UPON SEASON) 1. COMPLETE LANDSCAPING
 2. REMOVE SE&SC MEASURES.

22. TEMPORARY SEEDING SHALL CONSIST OF PERENNIAL RYEGRASS APPLIED AT A RATE OF 1.0 LBS. PER 1,000 SQ. FT. THE OPTIMUM SEED DEPTH SHALL BE 0.5 INCHES. TEMPORARY SEEDING SHALL BE MULCHED AND MAINTAINED UNTIL DISTURBED AREAS ARE PERMANENTLY STABILIZED WITH PERMANENT

OPTIMUM PLANTING PERIODS ARE BETWEEN AUGUST 15 AND OCTOBER 30. ACCEPTABLE PLANTING PERIODS ARE BETWEEN AUGUST 15 AND OCTOBER 30. ACCEPTABLE PLANTING PERIODS ARE BETWEEN FEBRUARY 1 AND APRIL 30 OR BETWEEN MAY 1 AND AUGUST 14. SUMMER SEEDINGS SHOULD ONLY BE CONDUCTED WHEN THE SITE IS IRRIGATED. MIXES INCLUDING WHITE CLOVER REQUIRE THAT AT LEAST SIX WEEKS OF GROWING SEASON REMAIN AFTER SEEDING TO ENSURE ESTABLISHMENT BEFORE FREEZING CONDITIONS.

COOL SEASON SEED MIXTURE #6 (WITHOUT WHITE CLOVER) FINE FESCUE BLEND (HARD FESCUE, CHEWINGS FESCUE,

STRONG CREEPING RED FESCUE) 0.10 LBS./1,000 SQ. FT. KENTUCKY BLUEGRASS 0.50 LBS./1,000 SQ. F1 0.10 LBS./1,000 SQ. FT. PERENNIAL RYEGRASS

A. APPLY GROUND LIMESTONE AND FERTILIZER ACCORDING TO SOIL TEST RECOMMENDATIONS AS OFFERED BY RUTGERS CO-OPERATIVE EXTENSION. SOIL SAMPLE MAILERS ARE AVAILABLE FROM THE LOCAL RUTGERS CO-OPERATIVE EXTENSION OFFICES. FERTILIZER SHALL BE APPLIED AT THE RATE OF 500 POUNDS PER ACRE OR 11 POUNDS PER 1,000 SQUARE FEET OF 10-20-10 OR EQUIVALENT WITH % WATER INSOLUBLE NITROGEN UNLESS A SOIL TEST INDICATES OTHERWISE, APPPLY LIMESTONE AT THE RATE OF 2 TONS/ACRE UNLESS SOIL TESTING INDICATES OTHERWISE. CALCIUM CARBONATE IS THE EQUIVALENT AND STANDARD FOR MEASURING THE ABILITY OF LIMING MATERIALS TO NEUTRALIZE SOI ACIDITY AND SUPPLY CALCIUM AND MAGNESIUM TO GRASSES AND LEGUMES.

B. WORK LIME AND FERTILIZER INTO THE SOIL AS NEARLY AS PRATICAL TO A DEPTH OF 4 INCHES WITH A DISC, SPRINGTOOTH HARROW, OR OTHER SUITABLE EQUIPMENT. THE FINAL HARROWING OR DISKING OPERATION SHOULD BE ON THE GENERAL CONTOUR. CONTINUE TILLAGE UNTIL A REASONABLE

C. INSPECT SEEDBED JUST BEFORE SEEDING. IF TRAFFIC HAS LEFT THE SOIL COMPACTED, THE AREA MUST BE RETILLED IN ACCORDANCE WITH THE ABOVE. D. SOILS HIGH IN SULFIDES OR HAVING A pH OF 4 OR LESS REFER TO STANDARD FOR MANAGEMENT

25. MAINTENANCE OF PERMANENT SOIL EROSION CONTROL MEASURES IS THE RESPONSIBILITY OF THE APPLICANT AND/OR SUBSEQUENT OWNERS OF THE PROPERTY. ALL SOIL FROSION AND SEDIMENT CONTROL PRACTICES TO BE INSTALLED PRIOR TO ANY MAJOR SOIL DISTURBANCES, OR IN THEIR PROPER SEQUENCE, AND MAINTAINED UNTIL PERMANENT PROTECTION IF ESTABLISHED. NO BUILDING PERMITS WILL BE RELEASED UNTIL ALL SOIL EROSION AND SEDIMENT CONTROL MEASURES, AS INDICATED ON APPROVED PLANS, ARE INSTALLED.

TOWNSHIP ENGINEER, CONTRACTORS AND UTILITY REPRESENTATIVES. IF THE TOWNSHIP ENGINEER DOES NOT SCHEDULE A PRE-CONSTRUCTION MEETING, IT IS THE RESPONSIBILITY OF THE OWNER/APPLICANT TO 28. FAILURE OF THE AFOREMENTIONED PLAN SHALL NOT RELIEVE THE APPLICANT OF ANY OF ITS RESPONSIBILITIES RELEVANT TO THE APPROPRIATE STATUTES. ADDITIONAL EROSION AND SEDIMENT


29. FINAL STABILIZATION OF ALL LAND DISTURBANCES ASSOCIATED WITH UNDERGROUND UTILITIES, IRRESPECTIVE OF PHASING, IS THE ULTIMATE RESPONSIBILITY OF THE OWNER. IF SEASON PREVENTS THE ESTABLISHMENT OF TEMPORARY OR PERMANENT SEEDING, EXPOSED


AREAS SHALL BE STABILIZED WITH MULCH. SEE THE MULCHING STANDARDS FOR MATERIALS AND

31. ANY STEEP SLOPES RECEIVING PIPELINE INSTALLATION WILL BE BACKFILLED AND STABILIZED DAILY, AS THE INSTALLATION CONTINUES (i.e. SLOPES GREATER THAN 3:1). ALL WORK TO BE DONE IN ACCORDANCE WITH THE STANDARDS FOR SOIL EROSION AND SEDIMENT

Table 29-1: Lengths of Construction Exits on Sloping Roadbeds

Percent Slope of Roadway	Length of Stone Required		
	Coarse Grained Soils	Fine Grained Soils	
0 to 2%	50 ft	100 ft	
2 to 5%	100 ft	200 ft	
>5%	Entire surface stabilized with FABC base course		

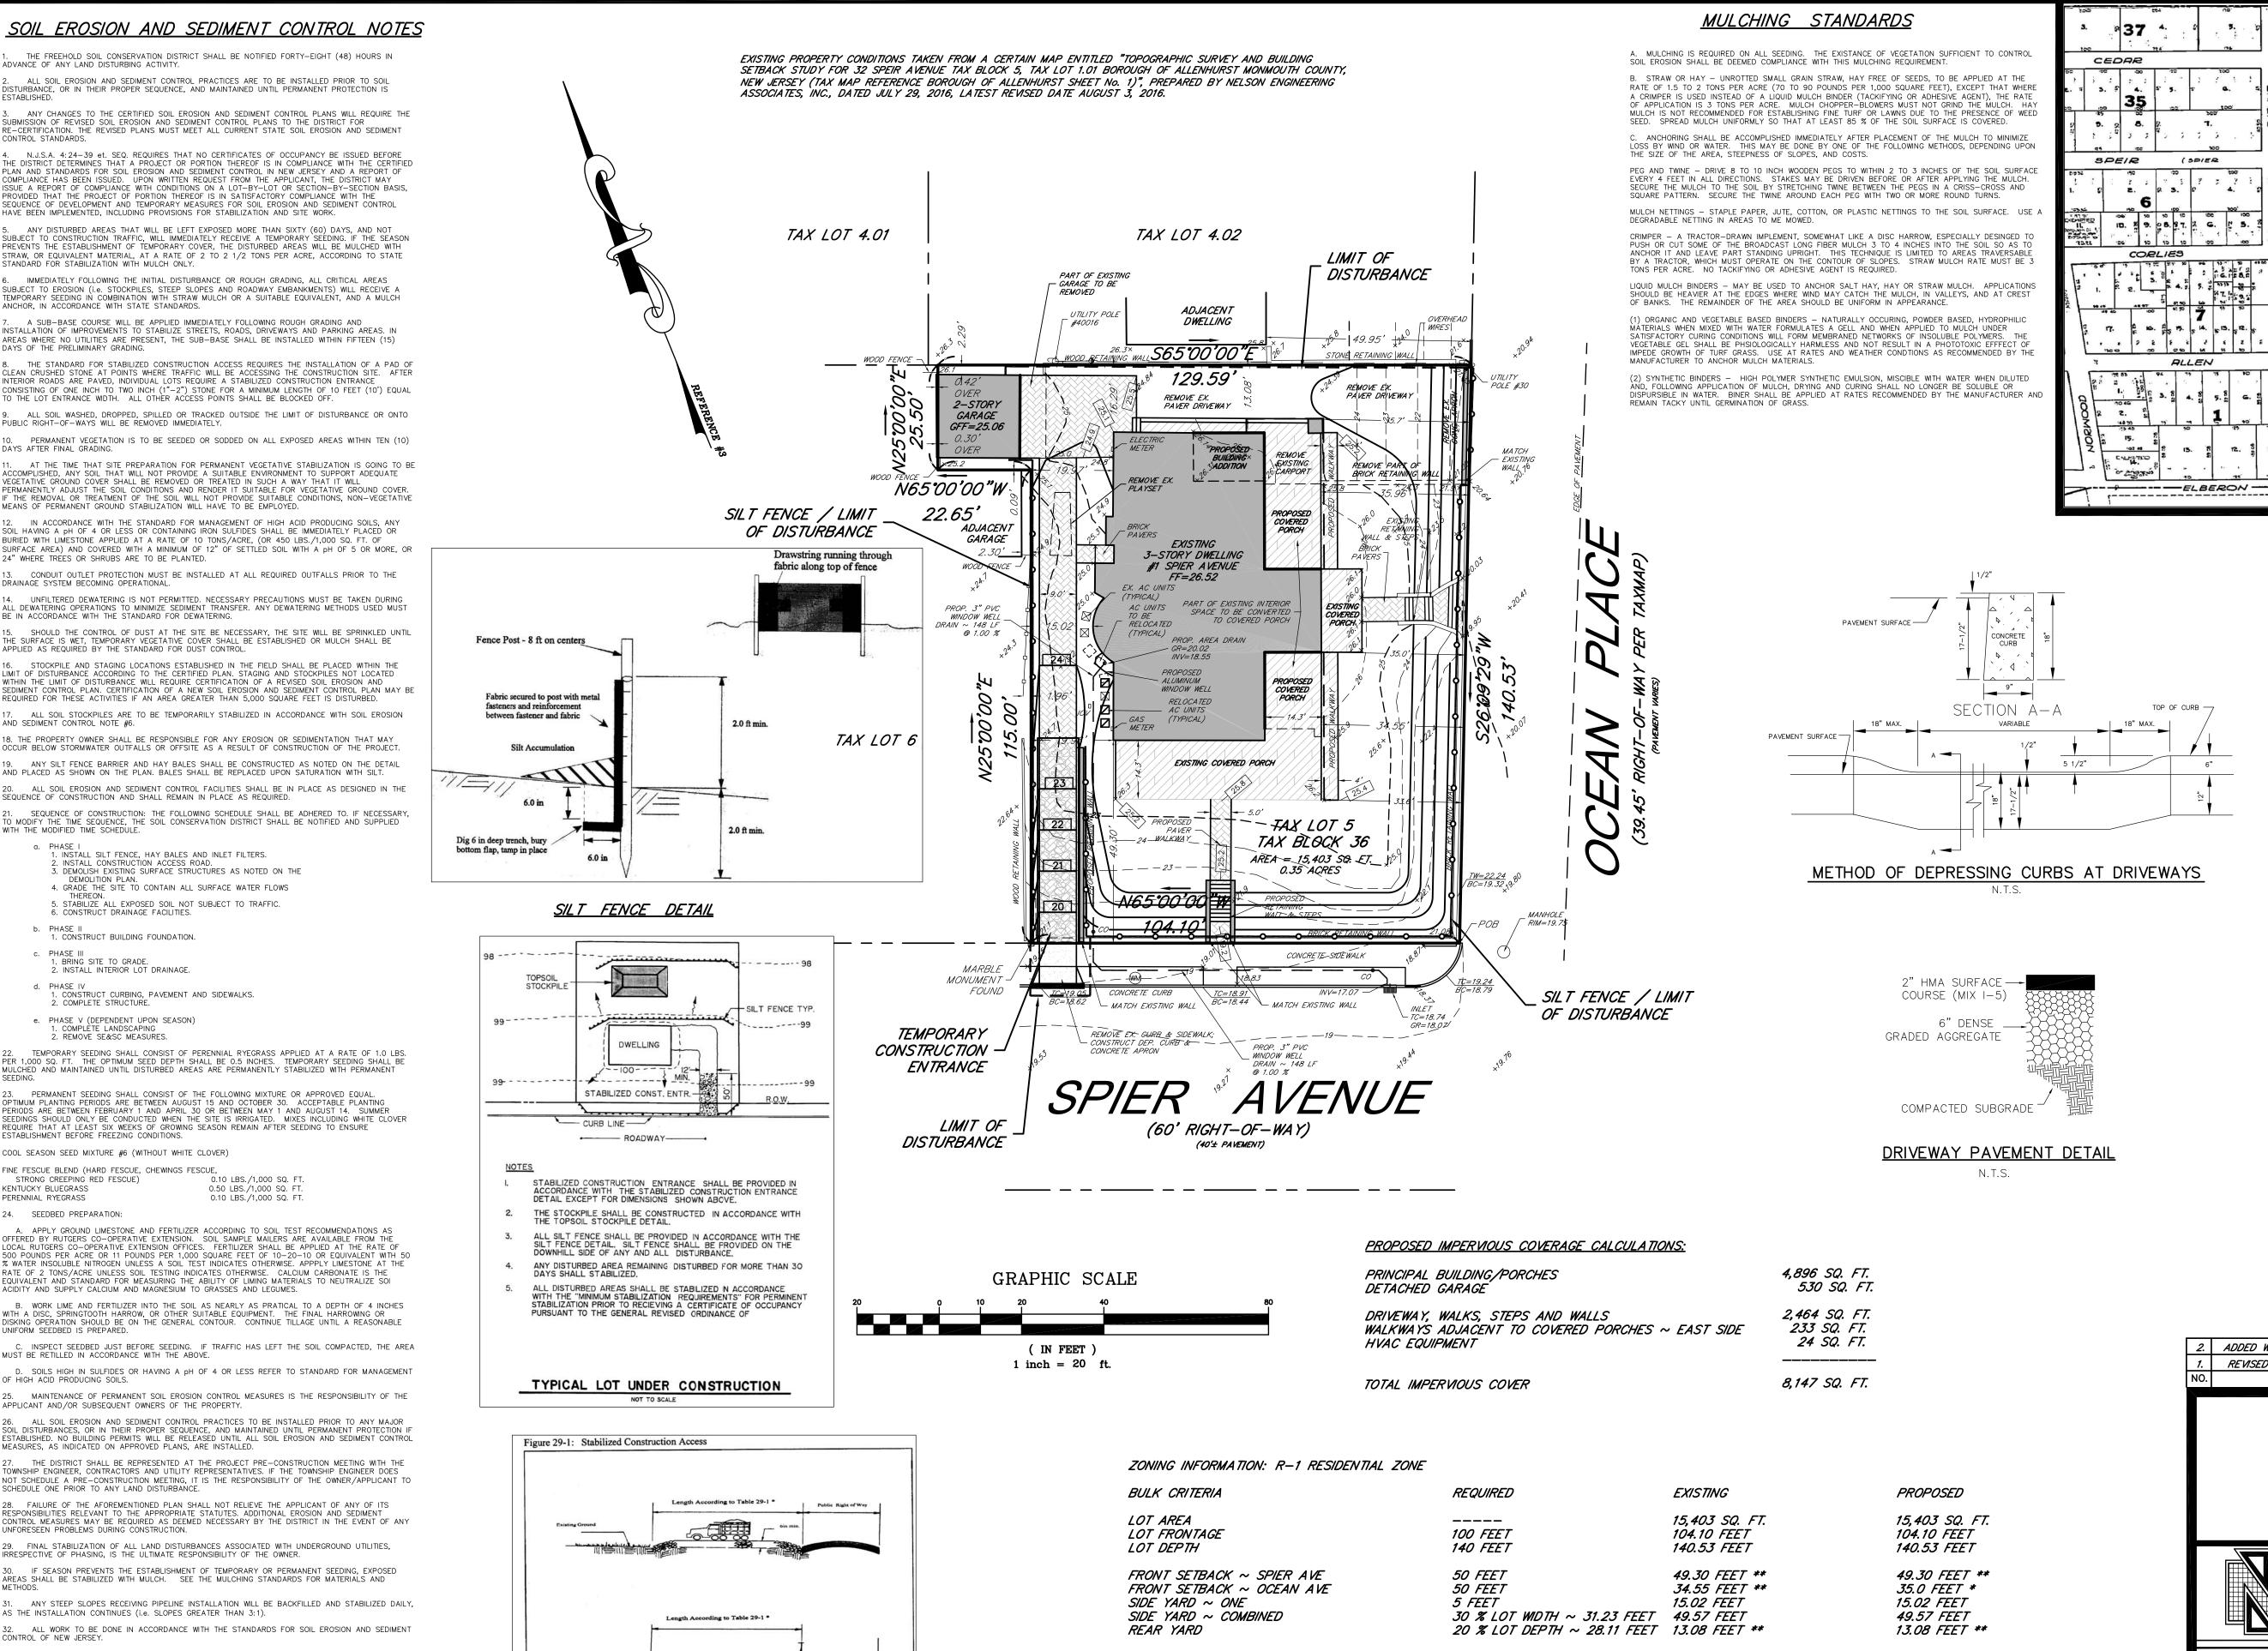

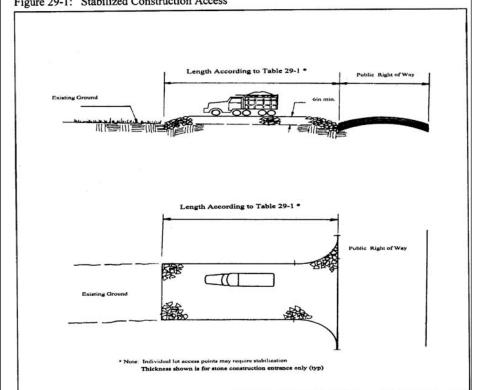



TEMPORARY CONSTRUCTION <u>ENTRANCE DETAIL</u>

ZONING INFORMATION: R-1	RESIDENTIAL ZONE			
BULK CRITERIA		REQUIRED	EXISTING	PROPOSED
LOT AREA LOT FRONTAGE LOT DEPTH		 100 FEET 140 FEET	15,403 SQ. FT. 104.10 FEET 140.53 FEET	15,403 SQ. FT. 104.10 FEET 140.53 FEET
FRONT SETBACK ~ SPIER . FRONT SETBACK ~ OCEAN SIDE YARD ~ ONE SIDE YARD ~ COMBINED REAR YARD	AVE	50 FEET 50 FEET 5 FEET 30 % LOT WIDTH ~ 31.23 FEET 20 % LOT DEPTH ~ 28.11 FEET		49.30 FEET ** 35.0 FEET * 15.02 FEET 49.57 FEET 13.08 FEET **
PRINCIPAL BUILDING HEIGH PRINCIPAL BUILDING COVER IMPERVIOUS COVERAGE	PAGE	35 FEET ~ 2.5 STORIES 20 % ~ 3,000 SQ. FT. 40 % ~ 6,000 SQ. FT.	FEET ~ 3 STORIES ** 31.78 % ~ 4,896 SQ. FT. ** 53.05 % ~ 8,172 SQ. FT. **	FEET ~ 3 STORIES ** 31.78 % ~ 4,896 SQ. FT. ** 52.89 % ~ 8,147 SQ. FT. *
ACCESSORY BUILDING FROI ACCESSORY BUILDING SIDE ACCESSORY BUILDING REAL	SETBACK	50 FEET 3.5 FEET 3.5 FEET	103 FEET -0.42 FEET ** 2.29 FEET **	103 FEET -0.42 FEET ** 2.29 FEET **


@ BUILDING COVERAGE INCLUDES THE DWELLING, COVERED FRONT AND REAR PORCHES. ** INDICATES AN EXISTING VARIANCE CONDITION.

* INDICATES AN EXISTING VARIANCE CONDITION IMPROVED.

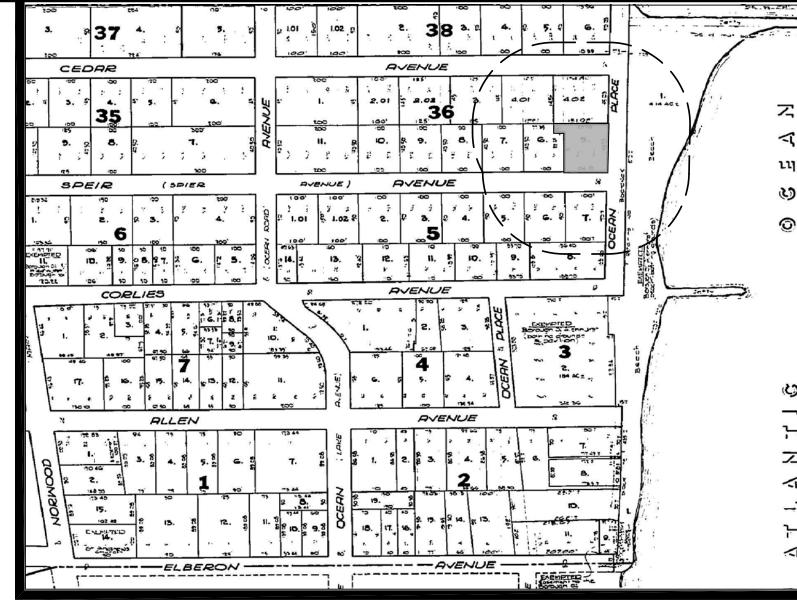

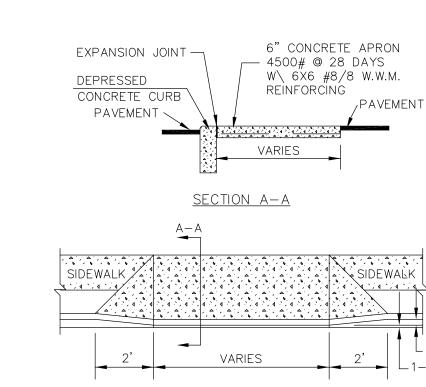

CONCRETE ENTRANCE APRON & DEPRESSED CURB

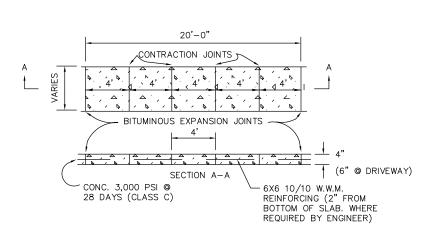


1.)A PREFORMED, BITUMINOUS EXPANSION JOINT 1/2" THICK, 4" WIDE, AND EXTENDING THE FULL WIDTH OF THE WALK, UNBROKEN, SHALL BE INSTALLED EVERY 20 FEET.
CONTRACTION JOINTS SHALL BE INSTALLED EVERY 4 FEET THE FULL WALK WIDTH. 2.)THERE SHALL BE A BROOM FINISH WITH THE EDGES FINISHED WITH A SUITABLE TOOL.

SIDEWALK DETAIL

N.T.S.

2. ADDED WINDOW WELL DRAIN REVISED PER CLIENT 4-3-17 | DHB | RAN DATE DRWN CHKD BY REVISION DESCRIPTION

> PLOT PLAN ~ SOIL EROSION CONTROL PLAN #1 SPIER AVENUE TAX BLOCK 36 , TAX LOT 5 BOROUGH OF ALLENHURST MONMOUTH COUNTY, NEW JERSEY (TAX MAP REFERENCE BOROUGH OF ALLENHURST SHEET No. 1)

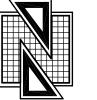

Nelson Engineering Associates, Inc.

1750 BLOOMSBURY AVENUE OCEAN , NEW JERSEY 07712 TEL. (732)-918-2180 FAX (732)-918-0697 WWW.NELSONENG.NET CERTIFICATE OF AUTHORIZATION # 24GA28014900

TRAFFIC ENGINEERING LANDSCAPE ARCHITECTURE ENVIRONMENTAL STUDIES LAND SURVEYING & MAPPING



PROFESSIONAL ENGINEER NEW JERSEY LICENSE No. 14293

SCALE: 1"=20' CHKD. BY: RAN DRAWN BY: DHB DATE: 02-01-2017 FILE: 161106 SHEET 1 OF 1